
PROPOSED SECOND UNIT 123 ANYWHERE STREET, BRAMPTON, ONTARIO

DRAWING LIST:

PROVIDE SURVEY (FOR REFERENCE ONLY)

A101	SAMPLE SITE PLAN	
A102 A103	SAMPLE EXISTING BASEMENT PLAN SAMPLE BASEMENT PLAN - OPTION 'A'	
A104	SAMPLE BASEMENT PLAN - OPTION 'B'	
A105	SAMPLE BASEMENT PLAN - OPTION 'C'	
A106	SAMPLE GROUND FLOOR PLAN	
A107	SAMPLE SECOND FLOOR PLAN	
A201	SAMPLE SIDE ELEVATION	EGRESS IN OP
A202	SAMPLE REAR ELEVATION	
A301	SAMPLE SECTIONS	
A302	WALL/ CEILING DETAILS	
A401	WINDOW DETAILS	
A402	FIRE BLOCKING DETAILS	
P101	SAMPLE BASEMENT PLAN - PLUMBING	
P102	SAMPLE BASEMENT PLAN - RISERS	
123 ANYWHERE ST	TREET, BRAMPTON	

123 ANYWHERE STREET, BRAMPTON

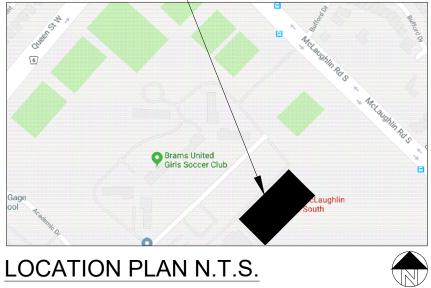



ION 'C' IS ONLY AVAILABLE AS A **ALTERNATIVE WHERE ZONING ITS CANNOT BE ACHIEVED FOR** PTIONS 'A' OR 'B'


> **CHANGE OF USE - TWO UNIT HOUSE** SAMPLE SITE PLAN JUNE 8th. 2019




CITY OF BRAMPTON, ON 8850 McLaughlin RD. UNIT #1 PLANNING AND INFRASTRUCTURE SERVICES

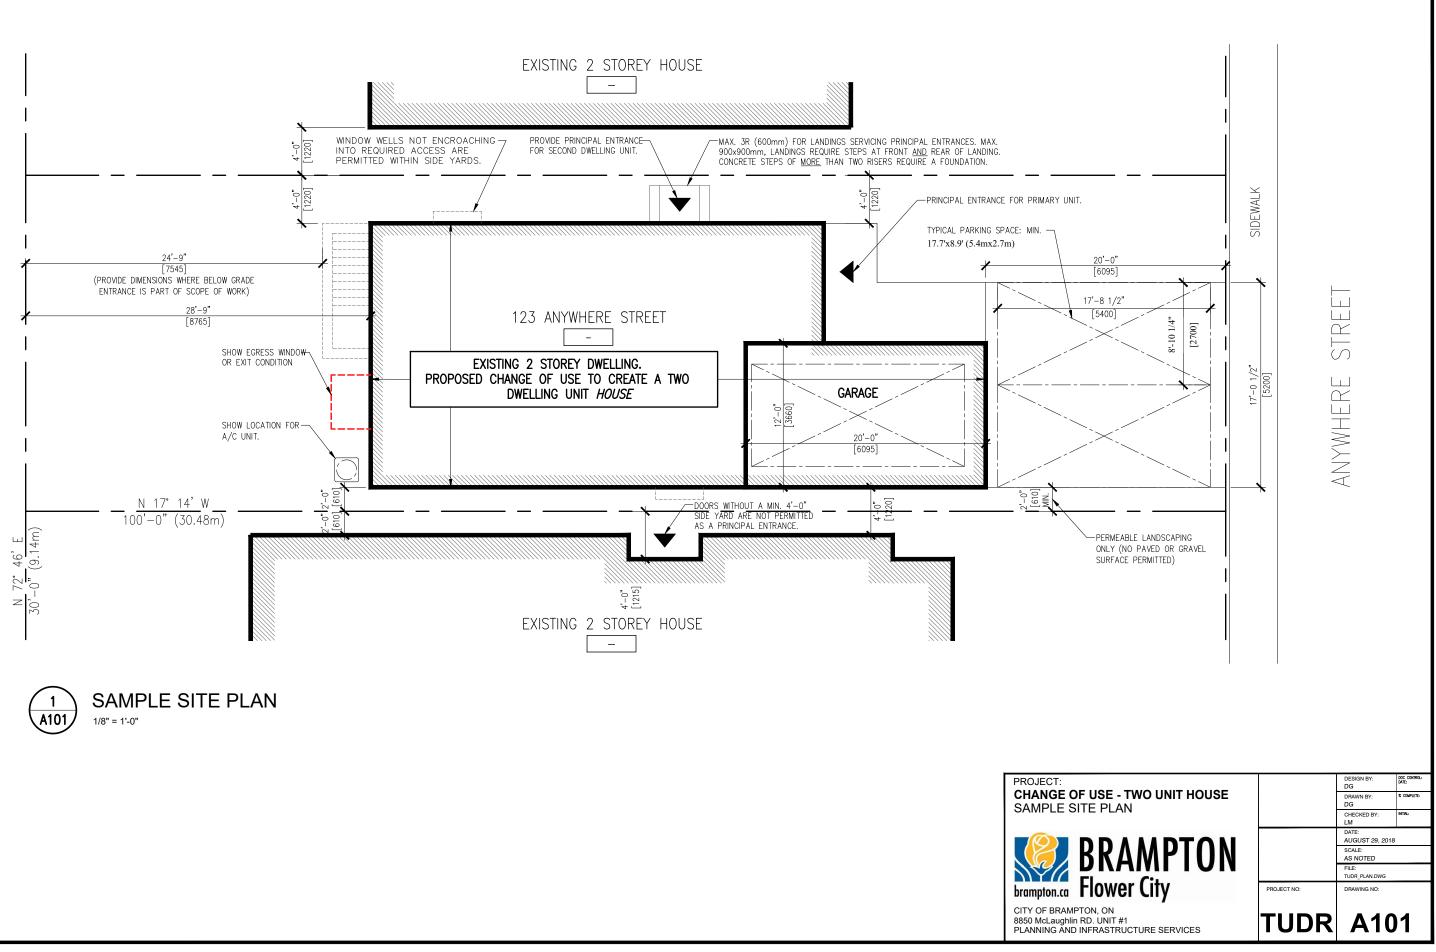


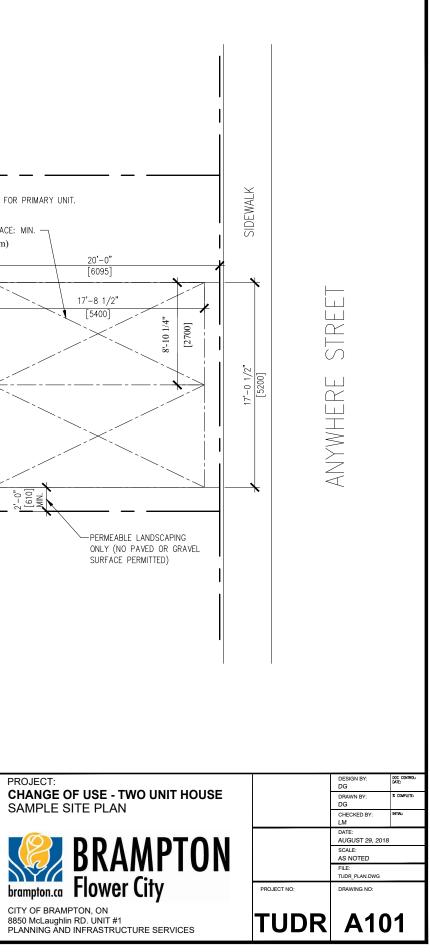


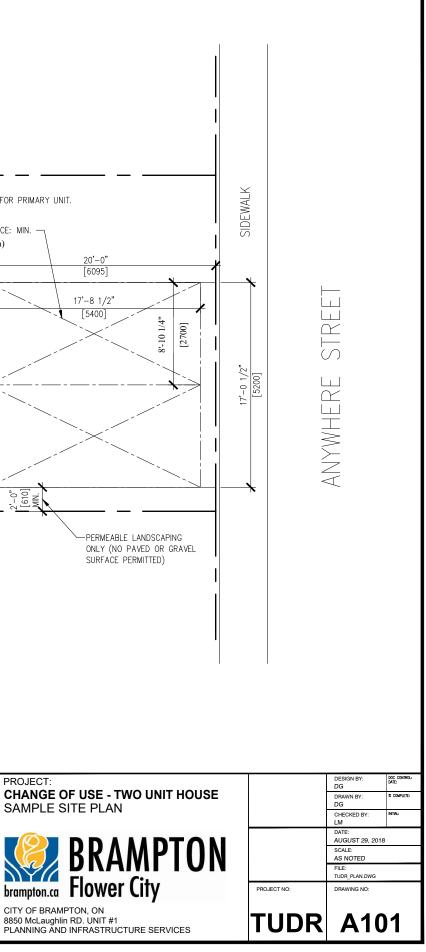

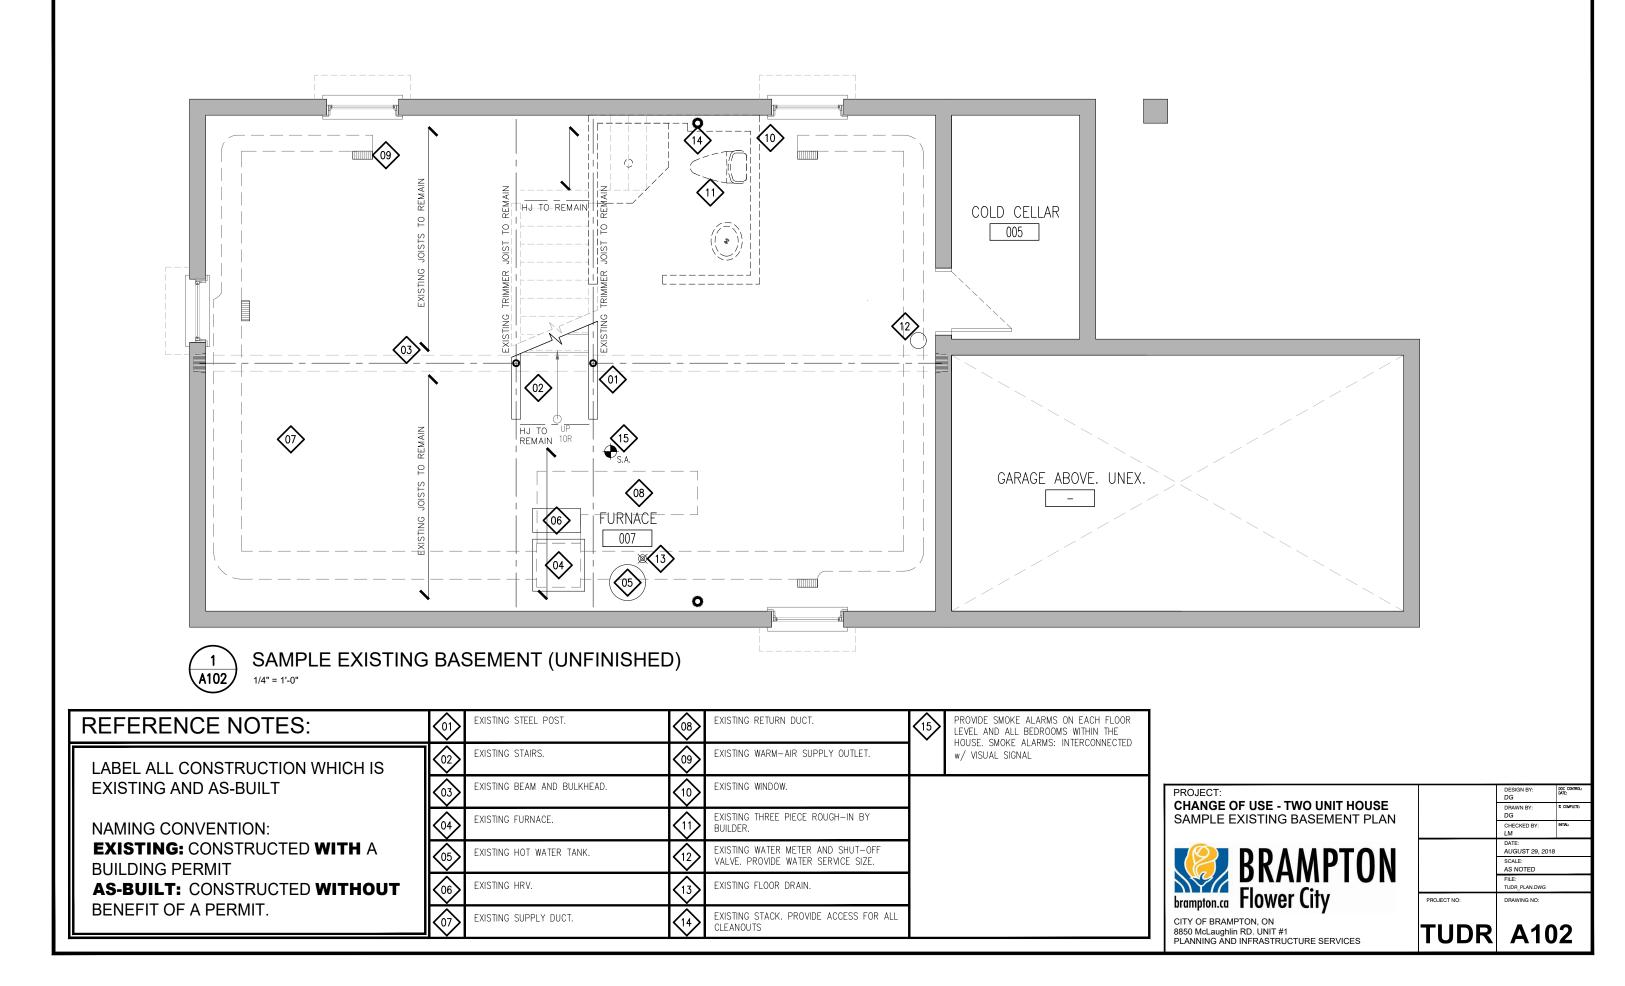



y	2 A301 37'-9"	P T
CH:7'-8' CH:7'-	W/D W/D W/D W/D W/D W/D W/D W/D	JNEX.
REFERENCE NOTES:	PROVIDE ALL ROOM NAMES. NOTE AT A MINIMUM DWELLING UNITS REQUIRE LIVING, DINING, KITCHEN, BATHROOM AND BEDROOM(S). PROVIDE SUPPLY GRILLES IN ALL ROOMS AND A RETURN AIR IN E UNIT ON ALL FLOORS. RETURNS: NOT PERMITTED IN FIRE SEPARAT	TIONS.
EGRESS OPTION 'A' EGRESS FROM THE BASEMENT UNIT BY WAY OF A BELOW GRADE ENTRANCE, WALK-OUT CONDITION <u>OR</u> INTERIOR STAIR,	PROVIDE DETAILS OF ALL PROPOSED WALL TYPES INCLUDING WALL PROVIDE FIRE SEPARATIONS BETWEEN SUITES, COMMON AREAS AN CEILING ASSEMBLIES PROVIDE ELECTRICAL LIGHTING IN EACH ROOM AND WALL SWITCHES. PROVIDE ELECTRICAL LIGHTING IN EACH ROOM AND WALL SWITCHES.	
PROVIDING ACCESS TO THE EXTERIOR, EXCLUSIVE TO THE SECOND UNIT.	PROVIDE A 3-WAY SWITCH AT THE TOP AND BOTTOM OF STAIRS.	UDE ALL S
PROVIDE DETAILS FOR ALL PROPOSED CONSTRUCTION AND ALL	WITHIN THE HOUSE. SMOKE ALARMS: INTERCONNECTED w/ VISUAL SIGNAL 44 RELEVANT EXISTING AND PROPOSED STRUCTURAL INFORMATION.	A
CONSTRUCTION BUILT WITHOUT BENEFIT OF A BUILDING PERMIT.	AND SELF CLOSING DEVICES. DOORS TO GARAGES SHALL BE GAS PROOF. (13) GAS AND ELECTRICITY TO THE FURNACE UPON ACTIVATION.	
 (5%) AND BEDROOMS (2.5%) PROVIDE CEILING HEIGHT UNDER BULKHEADS AND AT LOWEST POINTS. MINIMUM CEILING HEIGHT BEOLUER IS 1050mm (6', 5") THROLUCHOUT. 	AS-BUILT (IF CONSTRUCTED WITHOUT BENEFIT OF A PERMIT).	br
MINIMUM CEILING HEIGHT REQUIRED IS 1950mm (6'-5") THROUGHOUT.	ROOMS NOT EQUIPPED WITH A WINDOW PROVIDING NATURAL VENTILATION.	88 PL

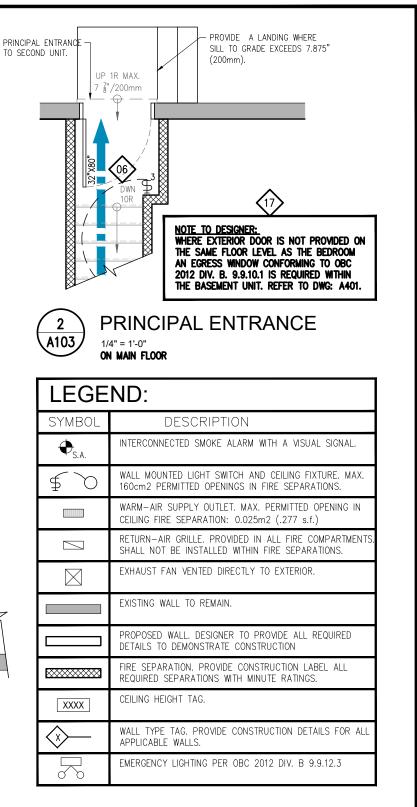

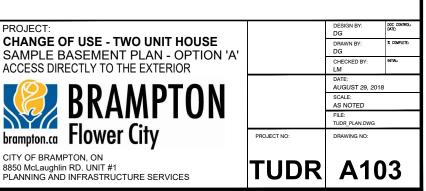

A104 SAMPLE PROPOSE 1/4" = 1'-0"	ED E	ASEMENT PLAN - OPTION 'B'			
REFERENCE NOTES:	0 4	PROVIDE ALL ROOM NAMES. NOTE AT A MINIMUM DWELLING UNITS REQUIRE LIVING, DINING, KITCHEN, BATHROOM AND BEDROOM(S).		PROVIDE SUPPLY GRILLES IN ALL ROOMS AND A RETURN AIR IN EACH UNIT ON ALL FLOORS. RETURNS: NOT PERMITTED IN FIRE SEPARATIONS.	
EGRESS OPTION 'B' EGRESS FROM THE BASEMENT UNIT THROUGH A SHARED.		PROVIDE DETAILS OF ALL PROPOSED WALL TYPES INCLUDING WALL CONSTRUCTION APPLIED TO EX. EXTERIOR WALLS. INSULATION, VB ETC.		PROVIDE FIRE SEPARATIONS BETWEEN SUITES, COMMON AREAS AND ALL CEILING ASSEMBLIES.	
PROTECTED STAIRWAY WHICH DOES NOT INVOLVE ENTERING ANOTHER UNIT OR AN AREA DEDICATED FOR ANOTHER PURPOSE (IE: LAUNDRY/ GARAGE etc.) WHICH LEADS TO THE EXTERIOR.		PROVIDE ELECTRICAL LIGHTING IN EACH ROOM AND WALL SWITCHES. PROVIDE A 3-WAY SWITCH AT THE TOP AND BOTTOM OF STAIRS.	13	DIMENSION ALL ROOMS, SPACES AND PROPOSED CONSTRUCTION.] [
		PROVIDE SMOKE ALARMS ON EACH FLOOR LEVEL AND ALL BEDROOMS WITHIN THE HOUSE. SMOKE ALARMS: INTERCONNECTED $w/$ VISUAL SIGNAL	14	ALL NEW OR ENLARGED OPENINGS SHALL BE DECLARED AND INCLUDE ALL RELEVANT EXISTING AND PROPOSED STRUCTURAL INFORMATION.	
PROVIDE DETAILS FOR ALL PROPOSED CONSTRUCTION AND ALL CONSTRUCTION BUILT WITHOUT BENEFIT OF A BUILDING PERMIT.		PROVIDE DOOR SIZES. LABEL ALL FIRE RATED DOORS w/ MINUTE RATINGS AND SELF CLOSING DEVICES. DOORS TO GARAGES SHALL BE GAS PROOF.	15	PROVIDE A DUCT-TYPE SMOKE DETECTOR WHICH WOULD SHUT OFF THE GAS AND ELECTRICITY TO THE FURNACE UPON ACTIVATION.	ſ
PROVIDE ALL DAYLIGHT REQUIREMENTS FOR LIVING AND DINING ROOM (5%) AND BEDROOMS (2.5%)	09	PROVIDE WINDOW SIZES AND LABEL AS EITHER: EXISTING, PROPOSED OR AS-BUILT (IF CONSTRUCTED WITHOUT BENEFIT OF A PERMIT).		PROVIDE AN EGRESS WINDOW FOR BEDROOMS PER OBC 2012 DIV. B.9.9.10.1. REFER TO DWG: A401 FOR DETAILS.	
PROVIDE CEILING HEIGHT UNDER BULKHEADS AND AT LOWEST POINTS. MINIMUM CEILING HEIGHT REQUIRED IS 1950mm (6'-5") THROUGHOUT.		PROVIDE EXHAUST FANS OVER RANGES, WITHIN BATHROOMS AND ALL ROOMS NOT EQUIPPED WITH A WINDOW PROVIDING NATURAL VENTILATION.	17	REQUIRED CLOSURE. MINIMUM 20min. RATED DOOR w/ SELF CLOSING DEVICE. PROVIDE SMOKE-TICHT SEAL.	
	-		-		•

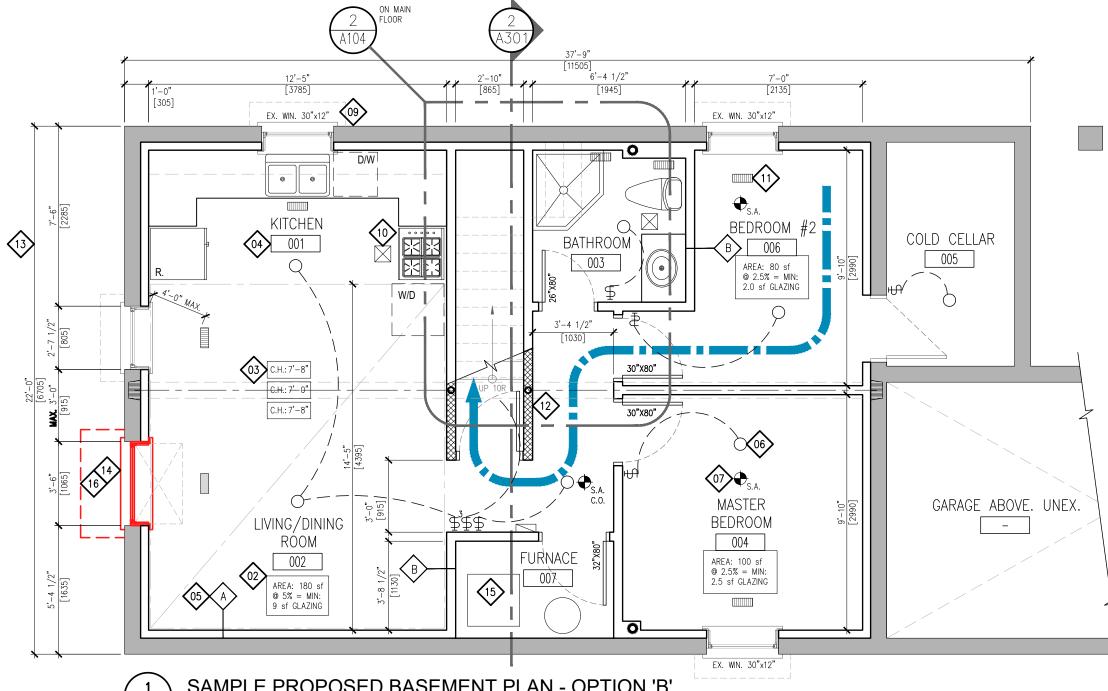

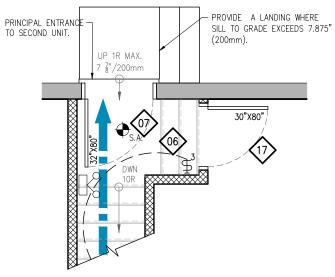


2 A104 (SHARED MEANS OF EGRESS) PRINCIPAL ENTRANCE 1/4" = 1'-0"

ON MAIN FLOOR


LEGE	LEGEND:				
SYMBOL	DESCRIPTION				
€ _{S.A.}	INTERCONNECTED SMOKE ALARM WITH A VISUAL SIGNAL.				
∳ ∕O	WALL MOUNTED LIGHT SWITCH AND CEILING FIXTURE. MAX. 160cm2 PERMITTED OPENINGS IN FIRE SEPARATIONS.				
	WARM-AIR SUPPLY OUTLET. MAX. PERMITTED OPENING IN CEILING FIRE SEPARATION: 0.025m2 (.277 s.f.)				
	RETURN-AIR GRILLE. PROVIDED IN ALL FIRE COMPARTMENTS. SHALL NOT BE INSTALLED WITHIN FIRE SEPARATIONS.				
\square	EXHAUST FAN VENTED DIRECTLY TO EXTERIOR.				
	EXISTING WALL TO REMAIN.				
	PROPOSED WALL. DESIGNER TO PROVIDE ALL REQUIRED DETAILS TO DEMONSTRATE CONSTRUCTION				
	FIRE SEPARATION. PROVIDE CONSTRUCTION LABEL ALL REQUIRED SEPARATIONS WITH MINUTE RATINGS.				
XXXX	CEILING HEIGHT TAG.				
\bigcirc	WALL TYPE TAG. PROVIDE CONSTRUCTION DETAILS FOR ALL APPLICABLE WALLS.				
\sim	EMERGENCY LIGHTING PER OBC 2012 DIV. B 9.9.12.3				

DJECT:		DESIGN BY: DG	DOC CONTROL: DATE:
ANGE OF USE - TWO UNIT HOUSE MPLE BASEMENT PLAN - OPTION 'B'		DRAWN BY: DG	% COMPLETE:
CESS TO EXTERIOR ON ANOTHER FLOOR		CHECKED BY: LM	INTAL:
		DATE: AUGUST 29, 2018	
🕖 BRAMPTON		SCALE: AS NOTED	
		FILE: TUDR_PLAN.DWG	
npton.ca Flower City	PROJECT NO:	DRAWING NO:	
Y OF BRAMPTON, ON McLaughlin RD. UNIT #1 NNING AND INFRASTRUCTURE SERVICES	TUDR	A10	4

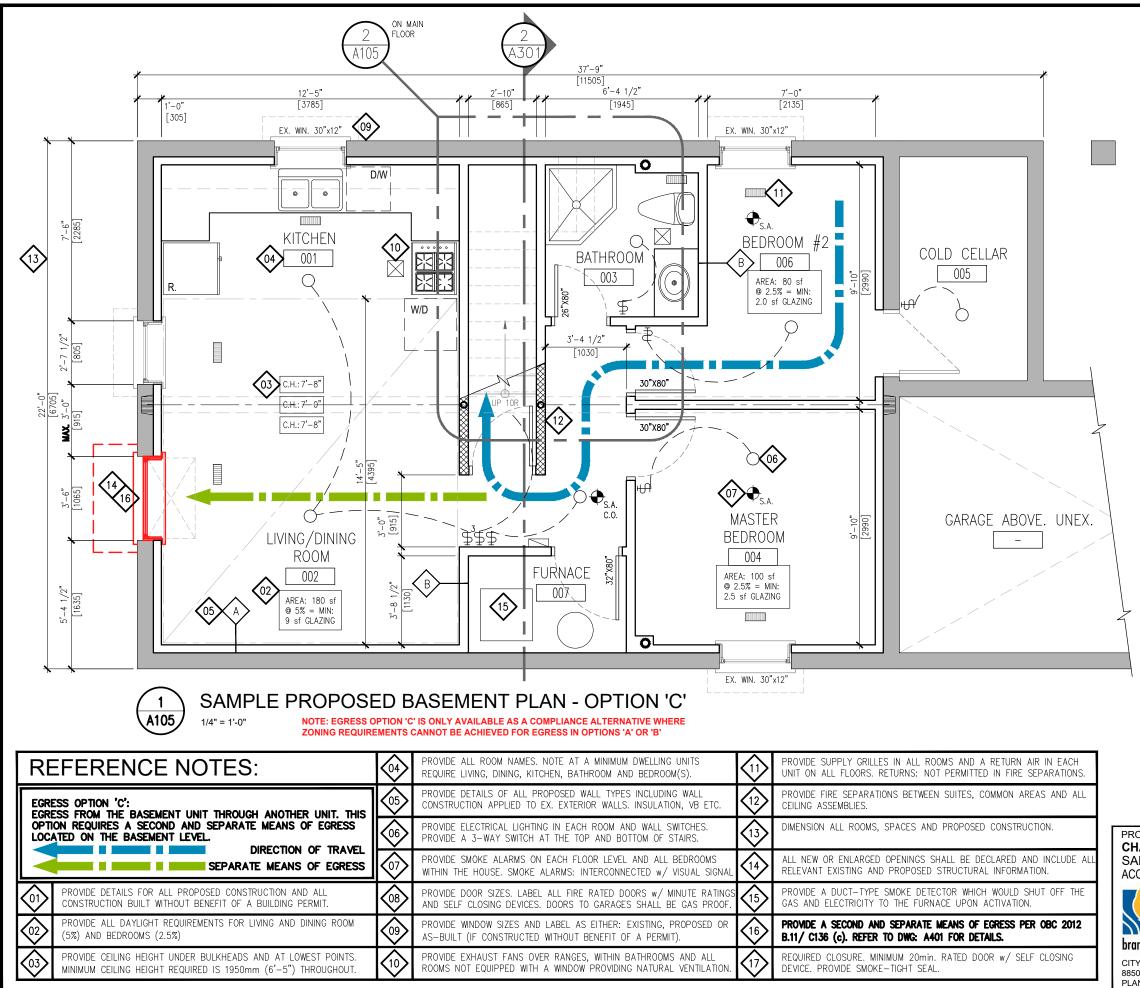

CITY 8850 PLAN

brar

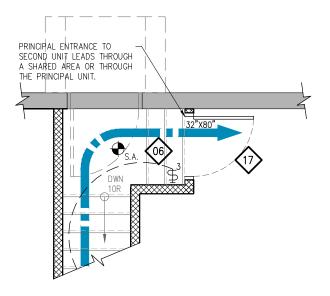




PRINCIPAL ENTRANCE

1/4" = 1'-0" ON MAIN FLOOR - THROUGH ANOTHER UNIT

LEGE	LEGEND:					
SYMBOL	DESCRIPTION					
€ _{S.A.}	INTERCONNECTED SMOKE ALARM WITH A VISUAL SIGNAL.					
€ Ò	WALL MOUNTED LIGHT SWITCH AND CEILING FIXTURE. MAX. 160cm2 PERMITTED OPENINGS IN FIRE SEPARATIONS.					
	WARM-AIR SUPPLY OUTLET. MAX. PERMITTED OPENING IN CEILING FIRE SEPARATION: 0.025m2 (.277 s.f.)					
	RETURN-AIR GRILLE. PROVIDED IN ALL FIRE COMPARTMENTS. SHALL NOT BE INSTALLED WITHIN FIRE SEPARATIONS.					
\square	EXHAUST FAN VENTED DIRECTLY TO EXTERIOR.					
	EXISTING WALL TO REMAIN.					
	PROPOSED WALL. DESIGNER TO PROVIDE ALL REQUIRED DETAILS TO DEMONSTRATE CONSTRUCTION					
	FIRE SEPARATION. PROVIDE CONSTRUCTION LABEL ALL REQUIRED SEPARATIONS WITH MINUTE RATINGS.					
XXXX	CEILING HEIGHT TAG.					
\bigcirc	WALL TYPE TAG. PROVIDE CONSTRUCTION DETAILS FOR ALL APPLICABLE WALLS.					
\sim	EMERGENCY LIGHTING PER OBC 2012 DIV. B 9.9.12.3					

DJECT:		DESIGN BY: DG	DOC CONTROL: DATE:
ANGE OF USE - TWO UNIT HOUSE MPLE BASEMENT PLAN - OPTION 'C'		DRAWN BY: DG	% COMPLETE:
CESS TO EXTERIOR THRU PRINCIPAL UNIT		CHECKED BY: LM	INITIAL:
		DATE: AUGUST 29, 2018	
🗾 BRAMPTON		SCALE: AS NOTED	
		FILE: TUDR_PLAN.DWG	
npton.ca Flower City	PROJECT NO:	DRAWING NO:	
OF BRAMPTON, ON	TUDD		
) McLaughlin RD. UNIT #1 NNING AND INFRASTRUCTURE SERVICES	TUDR	A10	15

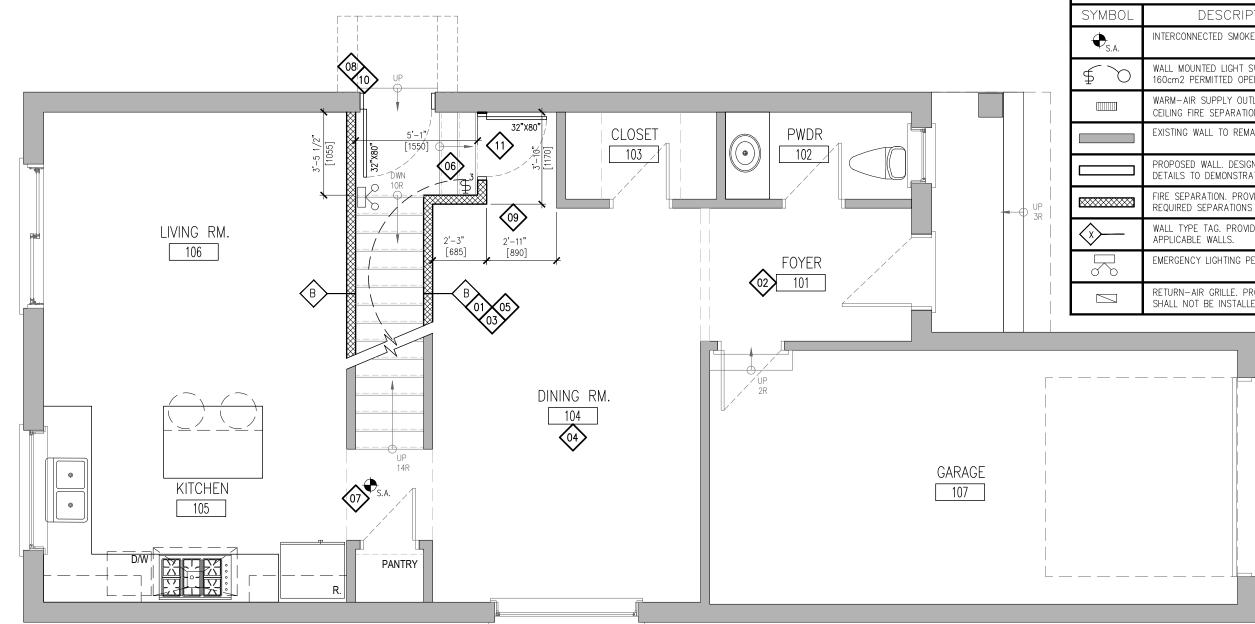





SAMPLE GROUND FLOOR PLAN 1/4" = 1'-0"

R	EFERENCE NOTES:		PROVIDE SMOKE ALARMS ON EACH FLOOR LEVEL AND ALL BEDROOMS WITHIN THE HOUSE. SMOKE ALARMS: INTERCONNECTED $w/$ VISUAL SIGNAL
	PROVIDE DETAILS FOR ALL PROPOSED CONSTRUCTION AND ALL CONSTRUCTION BUILT WITHOUT BENEFIT OF A BUILDING PERMIT.		PROVIDE DOOR SIZES. LABEL ALL FIRE RATED DOORS $w/$ MINUTE RATINGS AND SELF CLOSING DEVICES. DOORS TO GARAGES SHALL BE GAS PROOF.
	PROVIDE SUPPLY GRILLES IN ALL ROOMS AND A RETURN AIR IN EACH UNIT ON ALL FLOORS. RETURNS: NOT PERMITTED IN FIRE SEPARATIONS.	()9)	DIMENSION ALL ROOMS, SPACES AND PROPOSED CONSTRUCTION.
	PROVIDE FIRE SEPARATIONS BETWEEN SUITES, COMMON AREAS AND ALL CEILING ASSEMBLIES. VERTICAL: MIN. 30min/ HORIZONTAL: 15min.		ALL NEW OR ENLARGED OPENINGS SHALL BE DECLARED AND INCLUDE ALL RELEVANT EXISTING AND PROPOSED STRUCTURAL INFORMATION.
	PROVIDE ALL ROOM NAMES. NOTE AT A MINIMUM DWELLING UNITS REQUIRE LIVING, DINING, KITCHEN, BATHROOM AND BEDROOM(S).	$\langle 1 \rangle$	REQUIRED CLOSURE. MINIMUM 20min. RATED DOOR w/ SELF CLOSING DEVICE. PROVIDE SMOKE-TIGHT SEAL.
	PROVIDE DETAILS OF ALL PROPOSED WALL TYPES INCLUDING WALL CONSTRUCTION APPLIED TO EX. EXTERIOR WALLS. INSULATION, VB ETC.		
	PROVIDE ALL ELECTRICAL LIGHTING FACILITIES AND WALL SWITCHES. PROVIDE A 3-WAY SWITCH AT THE TOP AND BOTTOM OF STAIRS.		

	LEGEND:					
	SYMBOL DESCRIPTION					
	€ _{S.A.}	INTERCONNECTED SMOKE ALARM WITH A VISUAL SIGNAL.				
	\$ O	WALL MOUNTED LIGHT SWITCH AND CEILING FIXTURE. MAX. 160cm2 PERMITTED OPENINGS IN FIRE SEPARATIONS.				
		WARM-AIR SUPPLY OUTLET. MAX. PERMITTED OPENING IN CEILING FIRE SEPARATION: 0.025m2 (.277 s.f.)				
		EXISTING WALL TO REMAIN.				
		PROPOSED WALL. DESIGNER TO PROVIDE ALL REQUIRED DETAILS TO DEMONSTRATE CONSTRUCTION				
UP 3R		FIRE SEPARATION. PROVIDE CONSTRUCTION LABEL ALL REQUIRED SEPARATIONS WITH MINUTE RATINGS.				
 	\sim	WALL TYPE TAG. PROVIDE CONSTRUCTION DETAILS FOR ALL APPLICABLE WALLS.				
		EMERGENCY LIGHTING PER OBC 2012 DIV. B 9.9.12.3				
		RETURN-AIR GRILLE. PROVIDED IN ALL FIRE COMPARTMENTS. SHALL NOT BE INSTALLED WITHIN FIRE SEPARATIONS.				

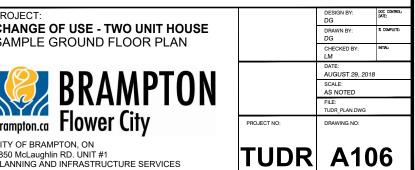

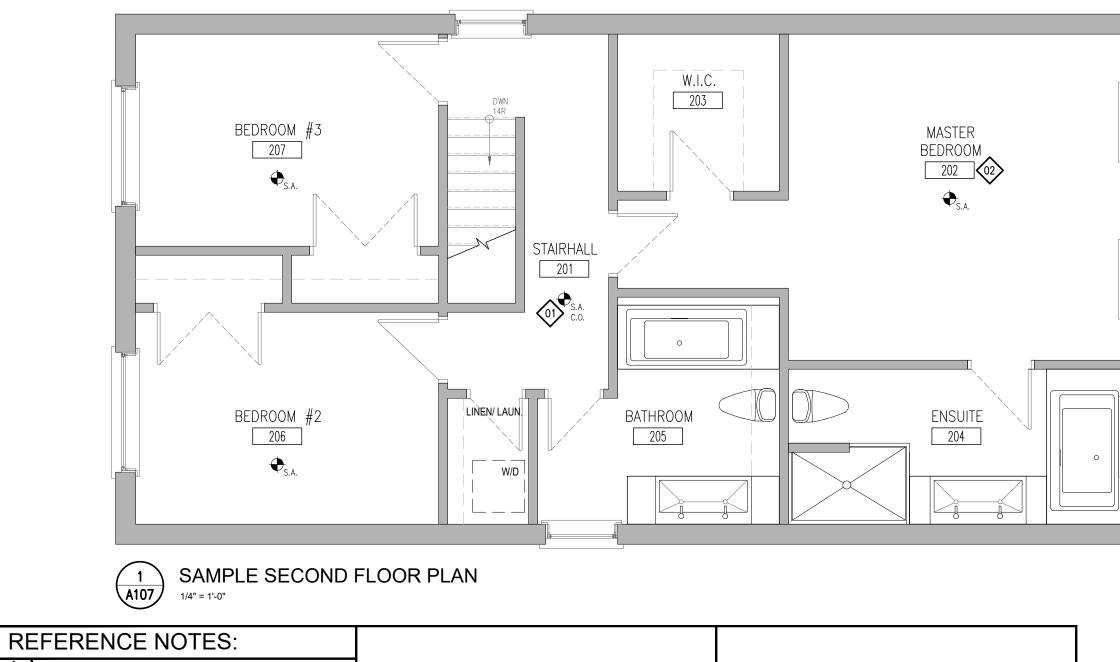





	LEGE	ND:			Π
	SYMBOL	DESCRI	PTION		
	€ _{S.A.}	INTERCONNECTED SMO	KE ALARM WITH A V	/ISUAL SIGNAL	
		EXISTING WALL TO REI	MAIN.		
]		PROPOSED WALL. DESI DETAILS TO DEMONST			
		FIRE SEPARATION. PRO REQUIRED SEPARATION			
		RETURN—AIR GRILLE P DWELLINGS. SHALL NO SEPARATIONS.			
				DESIGN BY: DG DRAWN BY: DG DRAWN BY:	DCC CAVIRS DATE 34 COMPLET
IPLE S	ECOND FLO	UR PLAN		CHECKED BY: LM DATE:	INITIAL:
2	RRAN	APTON		AUGUST 29, 2018 SCALE:	8
9//	DINAN			AS NOTED FILE: TUDR_PLAN.DWG	
pton.ca	Flower C	ity	PROJECT NO:	DRAWING NO:	


CITY OF BRAMPTON, ON 8850 McLaughlin RD. UNIT #1 PLANNING AND INFRASTRUCTURE SERVICES

TUDR A107

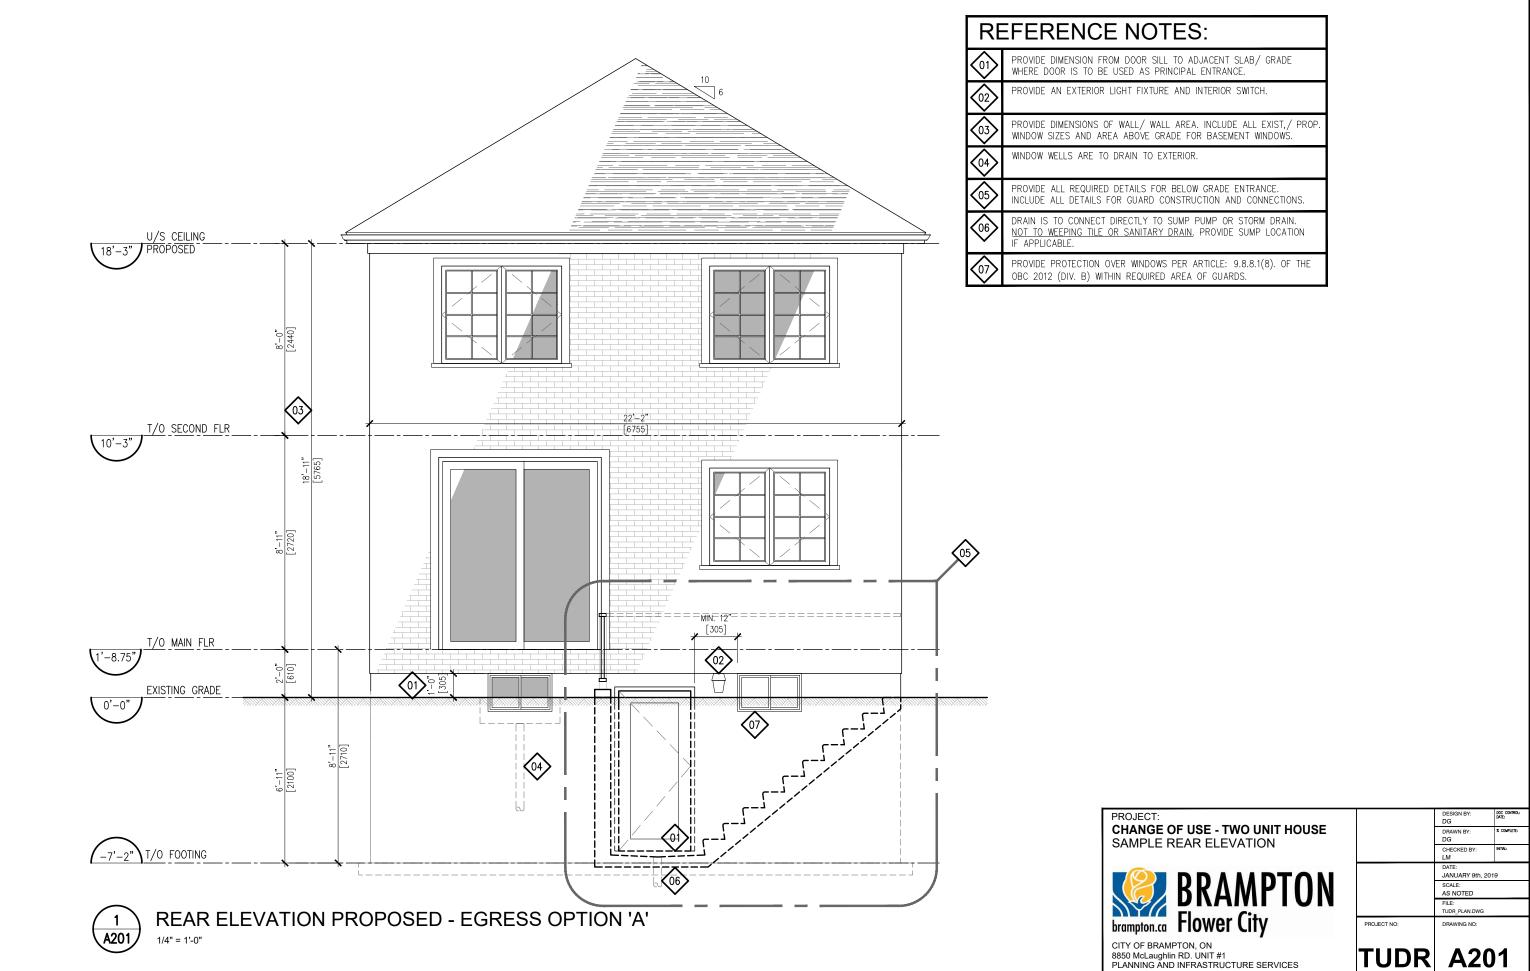

NOTES:
DOOR SILL TO ADJACENT SLAB/ GRADE D AS PRINCIPAL ENTRANCE.
T FIXTURE AND INTERIOR SWITCH.
ALL/ WALL AREA. INCLUDE ALL EXIST,/ PROP. BOVE GRADE FOR BASEMENT WINDOWS.
IN TO EXTERIOR.
AILS FOR BELOW GRADE ENTRANCE. GUARD CONSTRUCTION AND CONNECTIONS.
CTLY TO SUMP PUMP OR STORM DRAIN. ANITARY DRAIN. PROVIDE SUMP LOCATION

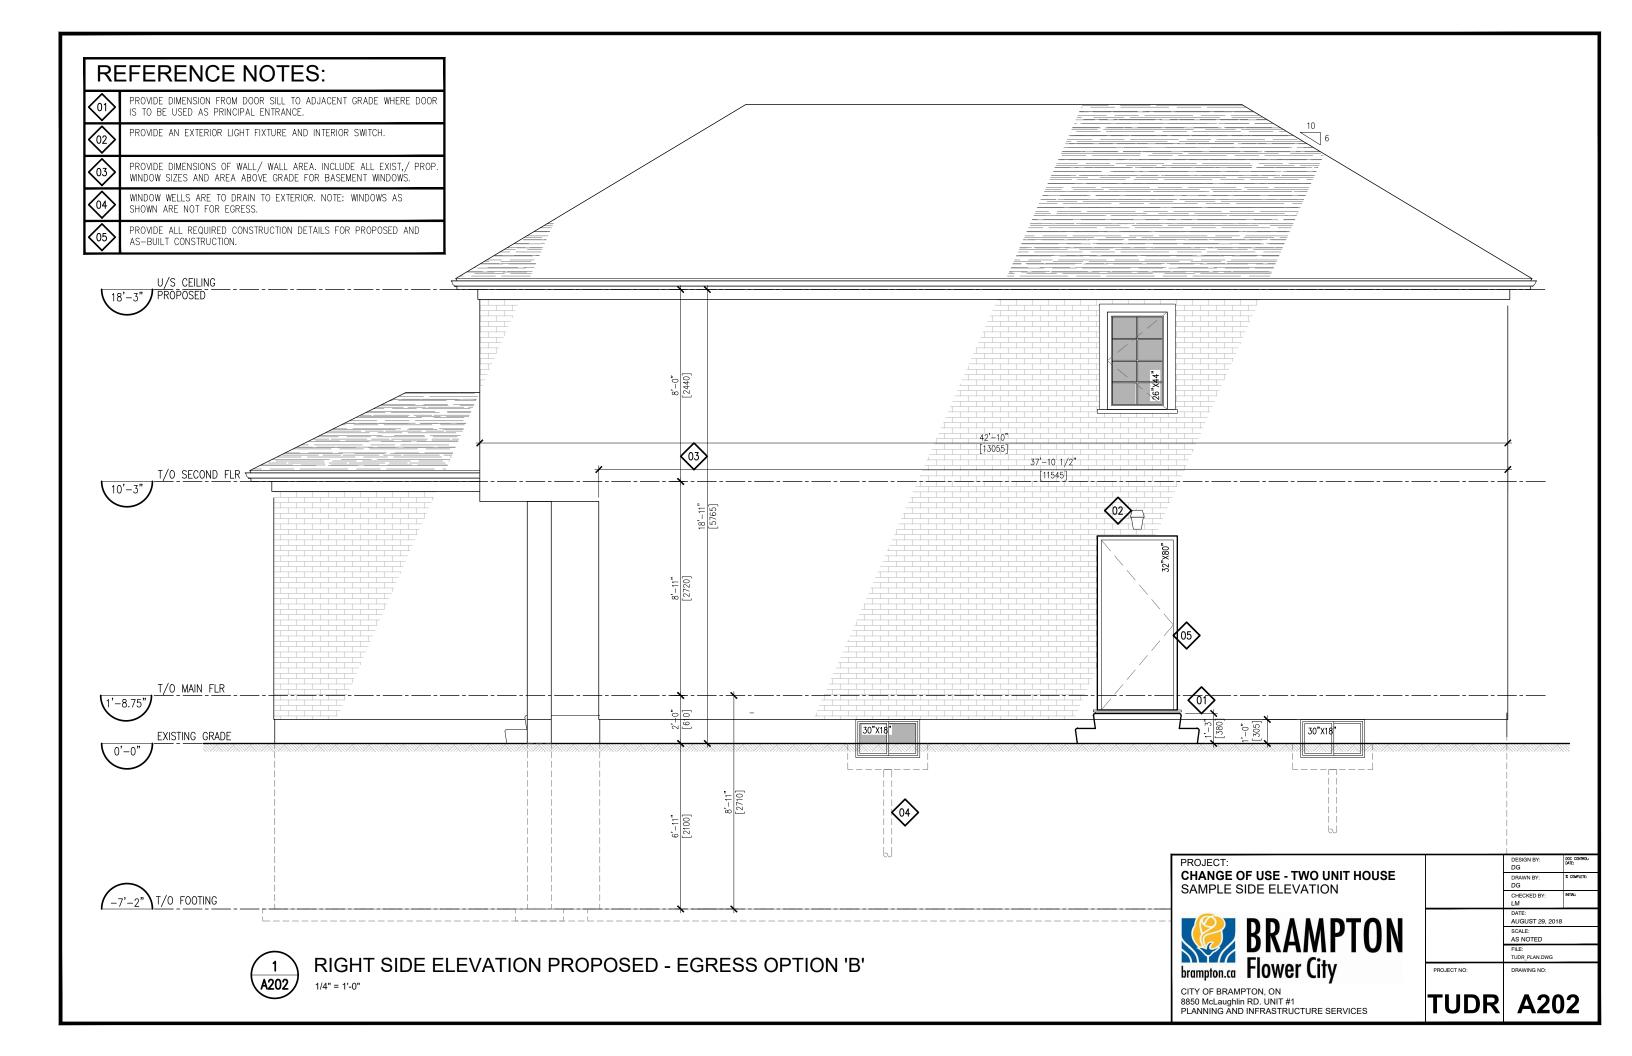

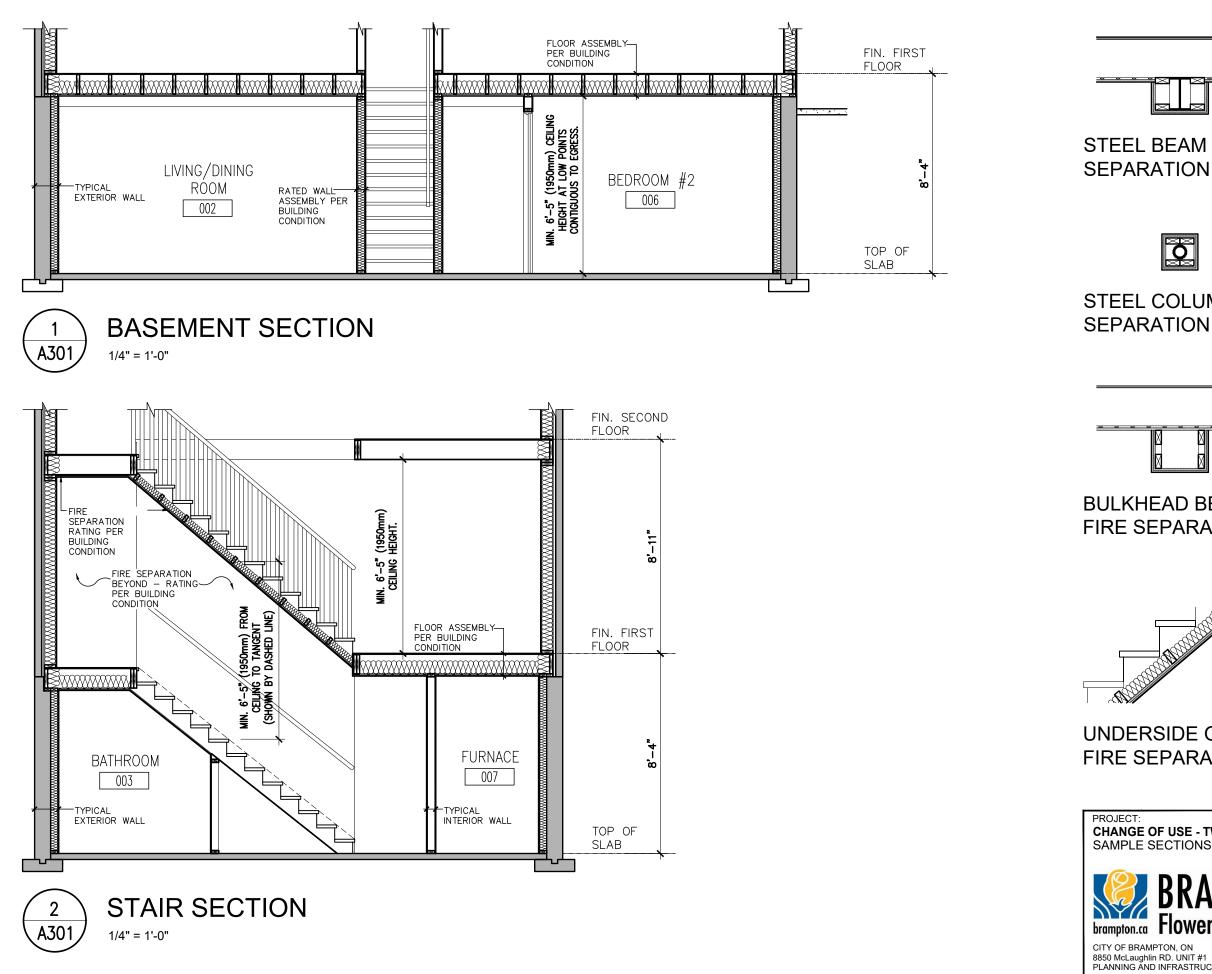

ARATION		
EL COLUMN PARATION	44" WOOD STUDS _AYERS TYPE 'X' PSUM BOARD TING PER BUILDING NDITION	
LKHEAD BELOW E SEPARATION	E SEPARATION LING ABOVE (4" WOOD STUDS 2" GYPSUM BOARD	
DERSIDE OF STAIR E SEPARATION	44" WOOD STUDS TO PPORT CEILING UND INSULATION PTIONAL) _AYERS TYPE 'X' PSUM BOARD TING PER BUILDING NDITION	
JECT: INGE OF USE - TWO UNIT HOUS MPLE SECTIONS BRANPTONS OF BRAMPTON, ON MCLaughlin RD. UNIT #1 NING AND INFERSTRUCTURE SERVICES	DS	
ANGE OF USE - TWO UNIT HOUS APLE SECTIONS	DS DRAWN 8Y: DS CHECKED BY: LM DATE: AUGUST 29, 2018 SCALE: AS NOTED FILE: TUDR,PLAN.DWG PROJECT NO:	

2"x4" WOOD FRAMING

2 LAYERS TYPE 'X'

GYPSUM BOARD RATING PER BUILDING CONDITION



PRC CH/

WA

WALL TYPES DEMONSTRATED ON THIS DRAWING ARE BASED ON WALL CONSTRUCTION DETAILS SPECIFIED IN THE SUPPLEMENTARY STANDARD SB-3. DESIGNER IS REQUIRED TO SPECIFY THE MINUTE RATING AND CONSTRUCTION OF ALL **REQUIRED FIRE SEPARATIONS.**

EXISTING PLYWOOD, OSB, OR

WOOD JOISTS OR WOOD I-JOISTS

(OPTIONAL 6" SOUND INSULATION)

RESILIENT CHANNELS @ 610mm O.C. 15.9mm TYPE 'X' GYPSUM BOARD

1/2" GYPSUM BOARD

WOOD STUDS

WALL ASSEMBLY W1c

FRR - 30 MIN. STC - N/A

BUILDING CONDITION B

2"x4" OR 2"x6" @ 16" O/C

ENTIRE STUD CAVITY FILLED

WITH SOUND INSULATION

1/2" GYPSUM BOARD

1/2" GYPSUM BOARD

WOOD STUDS

(OPTIONAL)

TYPICAL INTERIOR WALL

2"x4" OR 2"x6" @ 16" O/C

ENTIRE STUD CAVITY FILLED

WITH SOUND INSULATION

1/2" GYPSUM BOARD

SPACED NOT MORE THAN 610mm O.C. NO ABSORPTIVE MATERIAL IN CAVITY

WAFERBOARD SUBFLOOR

FLOOR ASSEMBLY F8b

FRR - 30 MIN. STC - 43

BUILDING CONDITION B

WALL ASSEMBLY W4a FRR - 1 HOUR STC - 51 **BUILDING CONDITION A**

EXTERIOR FOUNDATION WALL

2"x4" OR 2"x6" @ 16" O/C

MIN. R12 BATT INSULATION

1/2" GYPSUM BOARD

6 MIL. POLY VAPOUR BARRIER

WOOD STUDS

TYPICAL EXTERIOR WALL

15.5mm PLYWOOD, OSB, OR

WOOD JOISTS OR WOOD I-JOISTS

ABSORPTIVE MATERIAL IN CAVITY

RESILIENT CHANNELS @ 610mm O.C.

SPACED NOT MORE THAN 610mm O.C.

2 LAYERS 12.7mm TYPE 'X' GYPSUM BOARD

5/8" TYPE 'X' GYPSUM BOARD

2"x4" OR 2"x6" @ 16" O/C

3 1/2" SOUND INSULATION

2 LAYERS 5/8" TYPE 'X'

@ 16" OR 24" O/C

GYPSUM BOARD

RESILIENT METAL CHANNELS


WAFERBOARD SUBFLOOR

FLOOR ASSEMBLY F9h

FRR - 45 MIN. STC - 53

BUILDING CONDITION A

WOOD STUDS

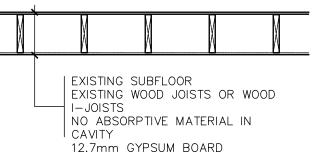


EXISTING FLOOR ASSEMBLY FRR - 15 MIN. STC - N/A **BUILDING CONDITION C**





1/2" GYPSUM BOARD 2"x4" OR 2"x6" @ 16" O/C WOOD STUDS ENTIRE STUD CAVITY FILLED WITH SOUND INSULATION (OPTIONAL) 1/2" GYPSUM BOARD


EXISTING RATED WALL FRR - 30 MIN. STC - N/A **BUILDING CONDITION C**

	DESIGN BY: DS	DOC CONTROL: DATE:
	DRAWN BY: DS	% COMPLETE:
	CHECKED BY: LM	INITIAL:
	DATE: AUGUST 29, 2018	
	SCALE: AS NOTED	
	FILE: TUDR_PLAN.DWG	
PROJECT NO:	DRAWING NO:	
TUDR	A30	2
		DS DRAWN BY: DS CHECKED BY: LM DATE: AUGUST 29, 2018 SCALE: AS NOTED FILE: TUDR_PLAN.DWG

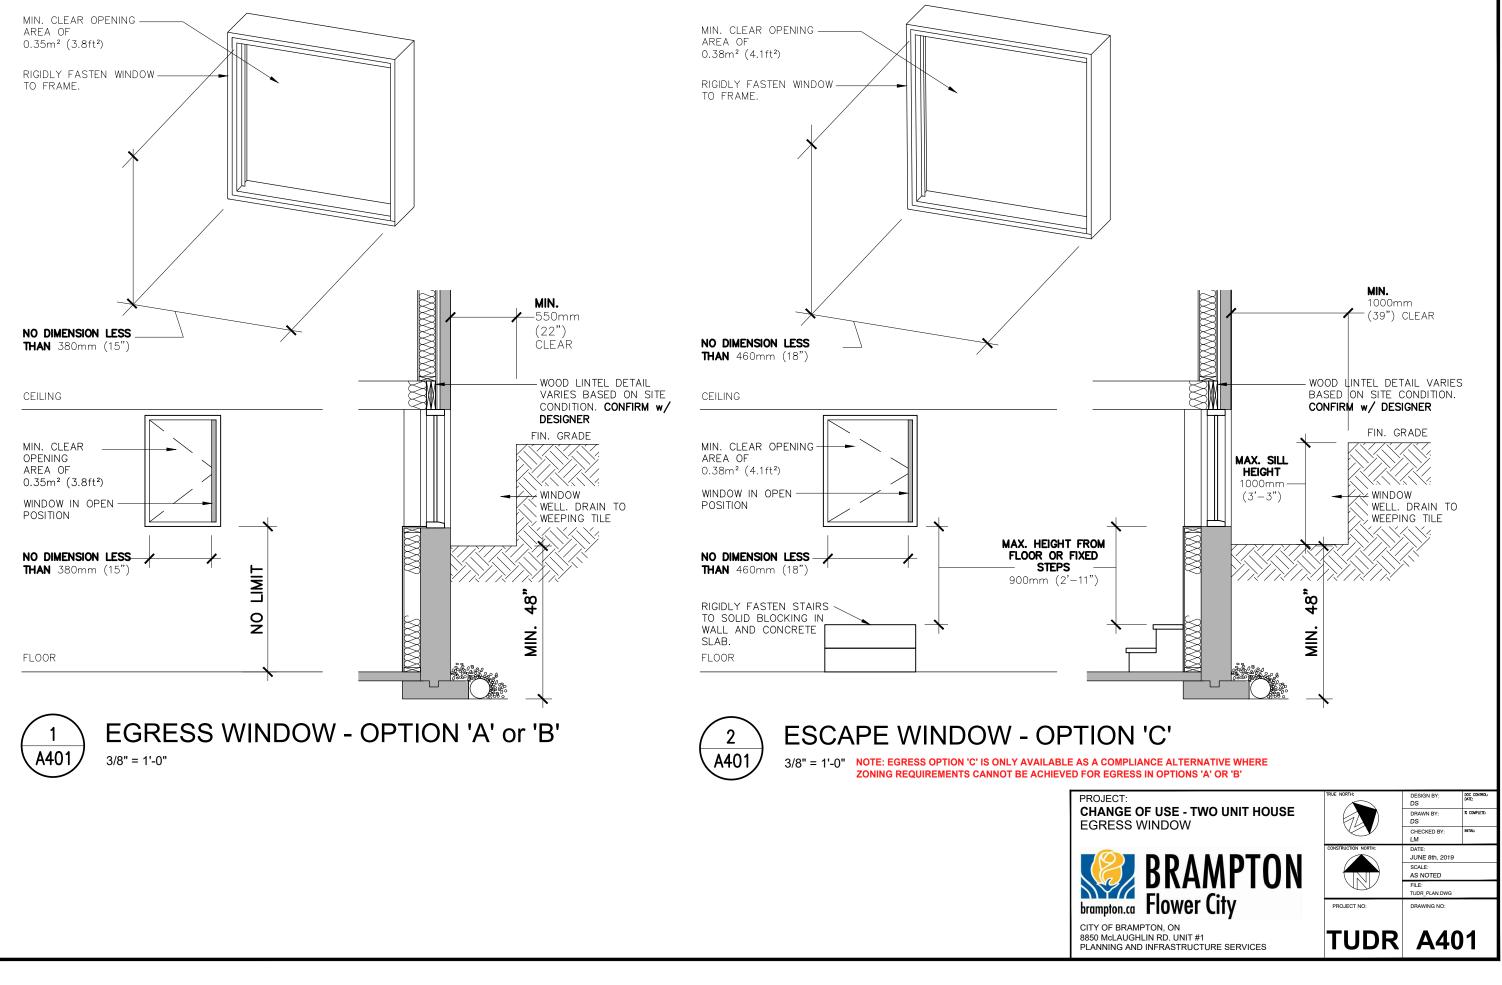


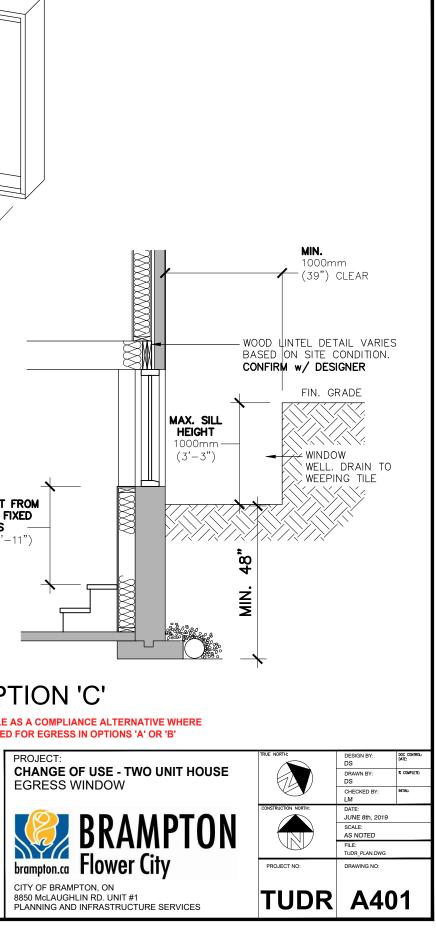

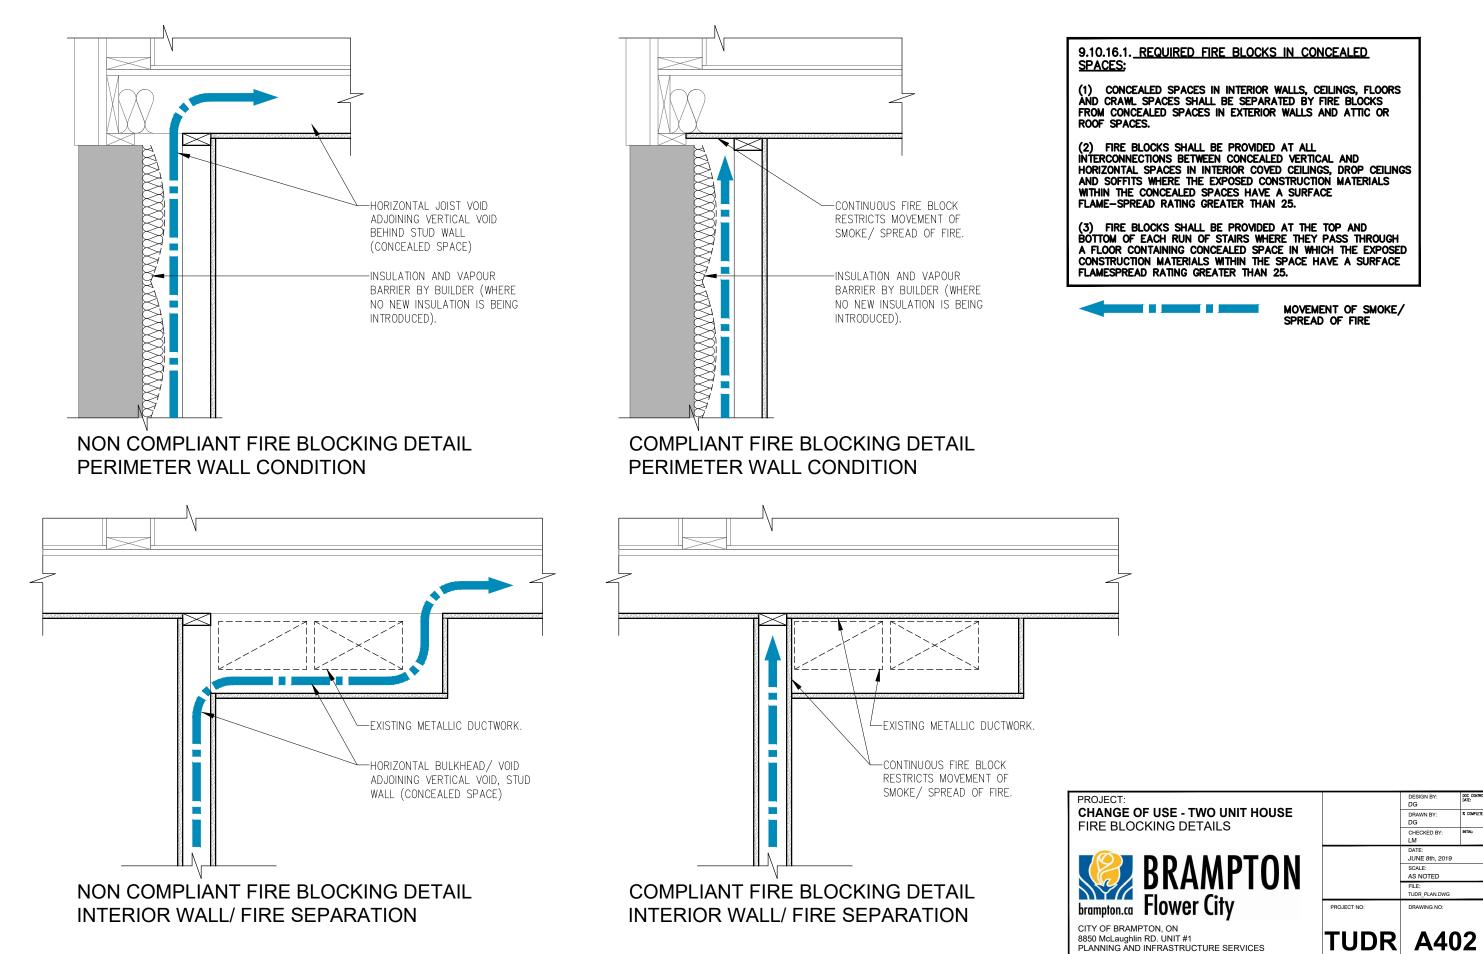

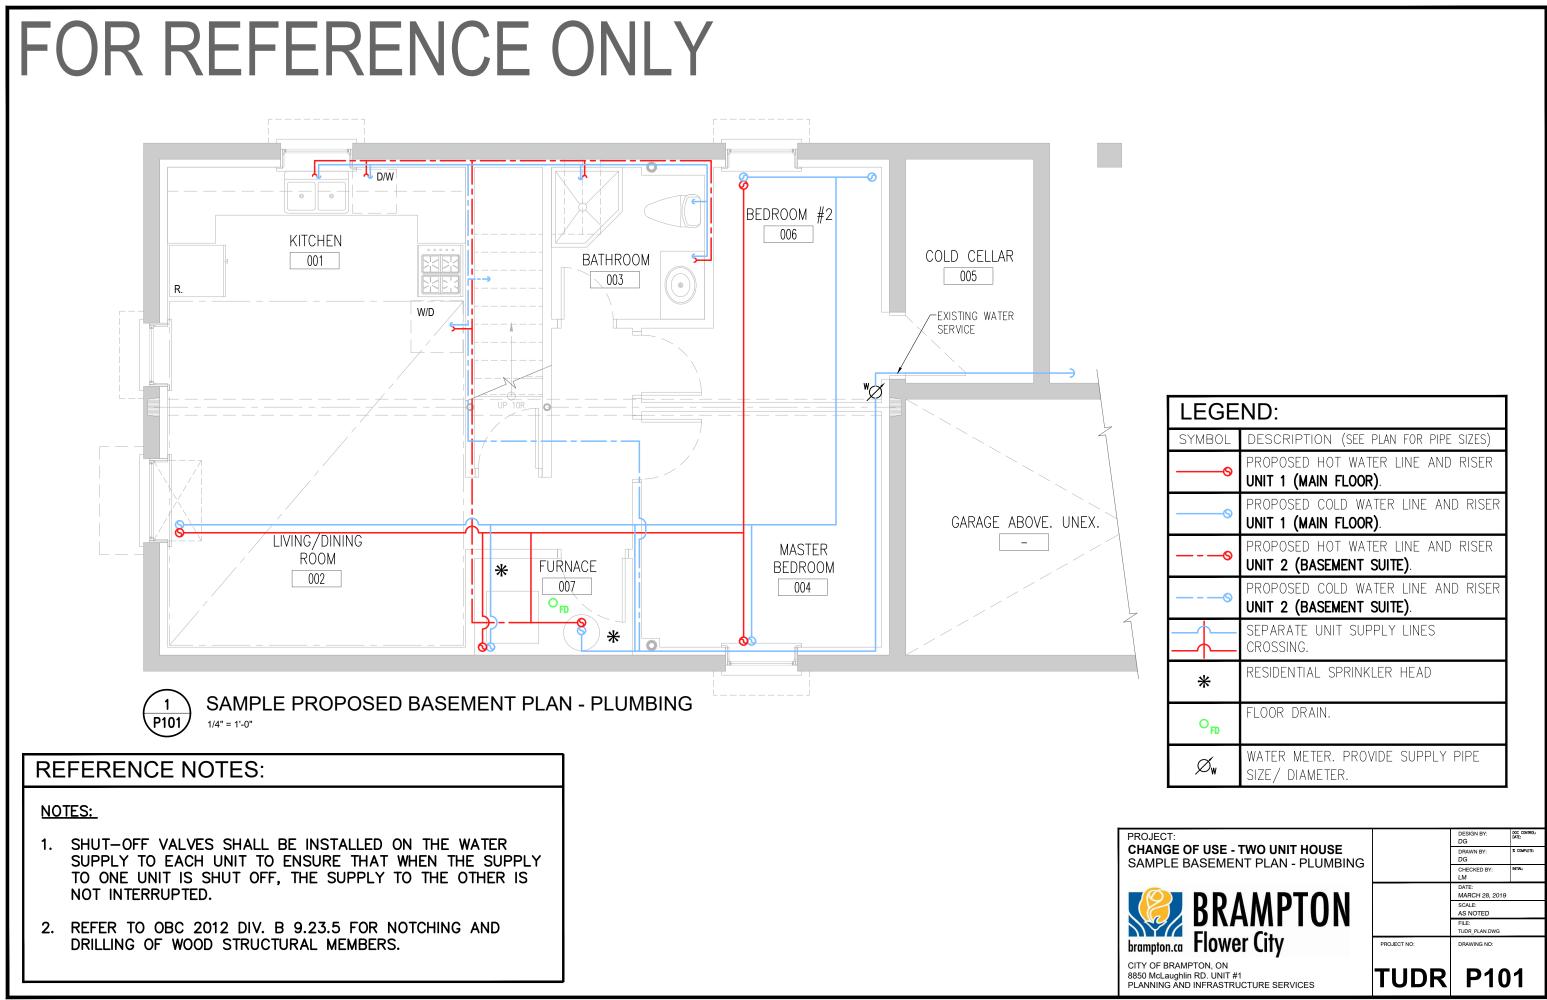

LEGEND:				
SYMBOL	DESCRIPTION (SEE PLAN FOR PIPE SIZES)			
Ø	PROPOSED HOT WATER LINE AND RISER UNIT 1 (MAIN FLOOR) .			
Ø	proposed cold water line and riser unit 1 (main floor) .			
Ø	PROPOSED HOT WATER LINE AND RISER UNIT 2 (BASEMENT SUITE).			
0	PROPOSED COLD WATER LINE AND RISER UNIT 2 (BASEMENT SUITE).			
$\left\{ \left\{ \right\} \right\}$	SEPARATE UNIT SUPPLY LINES CROSSING.			
*	RESIDENTIAL SPRINKLER HEAD			
O _{FD}	FLOOR DRAIN.			
\varnothing_{w}	WATER METER. PROVIDE SUPPLY PIPE SIZE/ DIAMETER.			

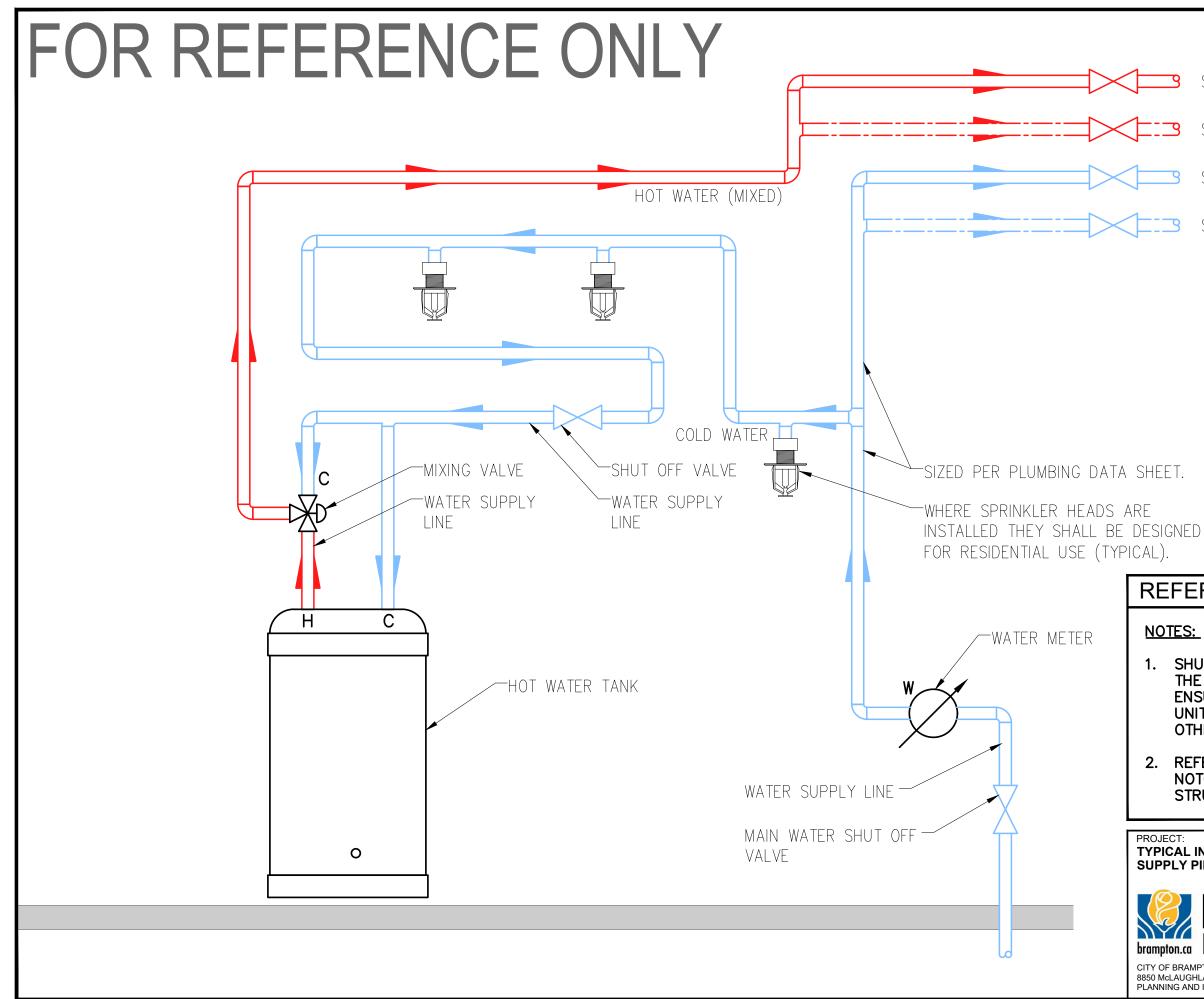

- SHUT OFF VALVE (HOT) UNIT 1
- SHUT OFF VALVE (HOT) UNIT 2 3
- SHUT OFF VALVE (COLD) UNIT 1
- SHUT OFF VALVE (COLD) UNIT 2

REFERENCE NOTES:

NOTES:

- 1. SHUT-OFF VALVES SHALL BE INSTALLED ON THE WATER SUPPLY TO EACH UNIT TO ENSURE THAT WHEN THE SUPPLY TO ONE UNIT IS SHUT OFF, THE SUPPLY TO THE OTHER IS NOT INTERRUPTED.
- 2. REFER TO OBC 2012 DIV. B 9.23.5 FOR NOTCHING AND DRILLING OF WOOD STRUCTURAL MEMBERS.

DJECT:		DESIGN BY: JR	DOC CONTROL: DATE:
PICAL INSTALLATION OF WATER		DRAWN BY: DG	% COMPLETE:
		CHECKED BY: LM	INITIAL:
		DATE: MARCH 28, 2019	
BRAMPTON		SCALE: AS NOTED	
		FILE: TUDR_PLAN.DWG	
mpton.ca Flower City	PROJECT NO:	DRAWING NO:	
Y OF BRAMPTON, ON DMCLAUGHLAN RD, UNIT #1	חחוד		2
NNING AND INFRASTRUCTURE SERVICES	TUDR	P10	Z